


CONSTRUCTION

TOP FLANGE TO BE 14 GA STAINLESS STEEL, 1/2" SQUARE TURN DOWN AND SECURED TO INTERIOR OF COLD PAN.

INTERIOR PAN TO BE 18 GA STAINLESS STEEL, FULLY WELDED, GROUND AND POLISHED, WITH A 3/4" OPEN DRAIN. TO BE FULLY INSULATED WITH 1 1/2" TO 2" URETHANE INSULATION. THE EXTERIOR JACKET TO CONSTRUCTED OF 26 GA. GALVANIZED STEEL.

REFRIGERATION SYSTEM TO BE A HERMETICALLY SEALED COMPRESSOR OPERATING ON R-507 (HFC) REFRIGERANT, AND WILL INCLUDE THE "TEMPEST-AIRE" CIRCULATING COLD AIR SYSTEM. THERMOSTAT CONTROL WILL CLEAR THE COOLING SURFACE OF FROST ON EVERY CYCLE. ALL SWITCHES AND CONTROLS TO BE FULLY ACCESSIBLE. PROVIDED WITH A CORD AND PLUG.

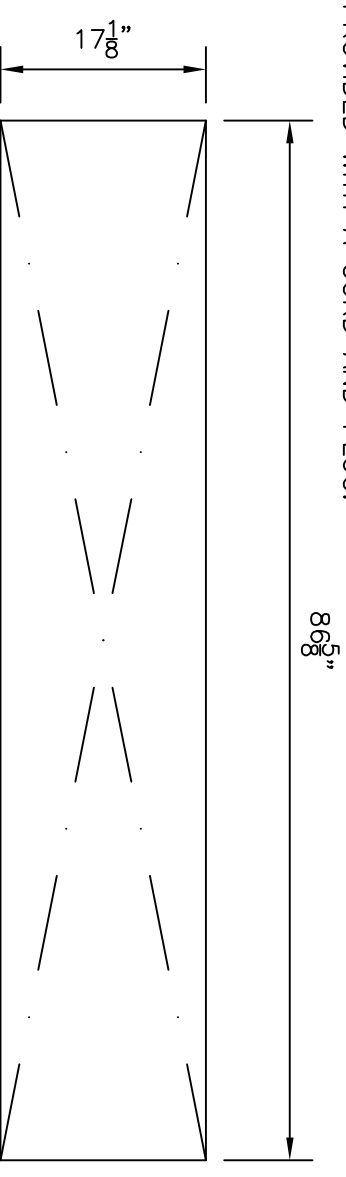

CUT-OUT REQ'D.

FRONT ELEVATION

END VIEW

ITEM #
TEMP-EST AIRE DROP IN COLD PAN
ONE (1) REQUIRED SCALE 3/4" = 1' = 0"

MODEL #DI-1282TA-T-SLIM
ELECT - 120V - 8.5A - 5-15 PLUG
COMPRESSOR - 1/3 HP



—NOTE—
COLD PAN CONSTRUCTED TO ACCEPT
FOUR (4) FULL SIZE PANS UP TO
6" DEEP

MASTER SWITCH

DUPLEX RECEPTACLE
HUBBELL #GF5262
NEMA 5-15R

FURNISH 1/9TH SIZE PAN WITH
JUNCTION BOX AND BALL BAT SWITCH
TO BE WIRED TO RECEPTACLE.

FURNISH 36" OF FLEX AND
PRE-WIRE FROM SWITCH TO
RECEPTACLE COLD PAN TO BE
PLUGGED INTO SWITCHED RECEPTACLE

ORDER #:		DRAWN BY: C.HAMMONDS		REVISIONS:		REVISIONS: 4-22-10CFH		SCALE: 3/4" = 1'-0"	
DATE: 4-27-11		SHEET# K-1 OF 1		DWG#		DI-1282TA-T-SLIM		ORIGINAL	
DEALER:		PROJECT: FOUR (4) PAN SLIM LINE TEMP-EST AIRE DROP IN UNIT		LOW TEMP INDUSTRIES, INC. • P.O. BOX 795 • JONESBORO, GA 30237-0795 • (770) 478-8803		MANUFACTURING		CHECKED BY:	
								ANSI / NFPA, NF7	
								LISTED	